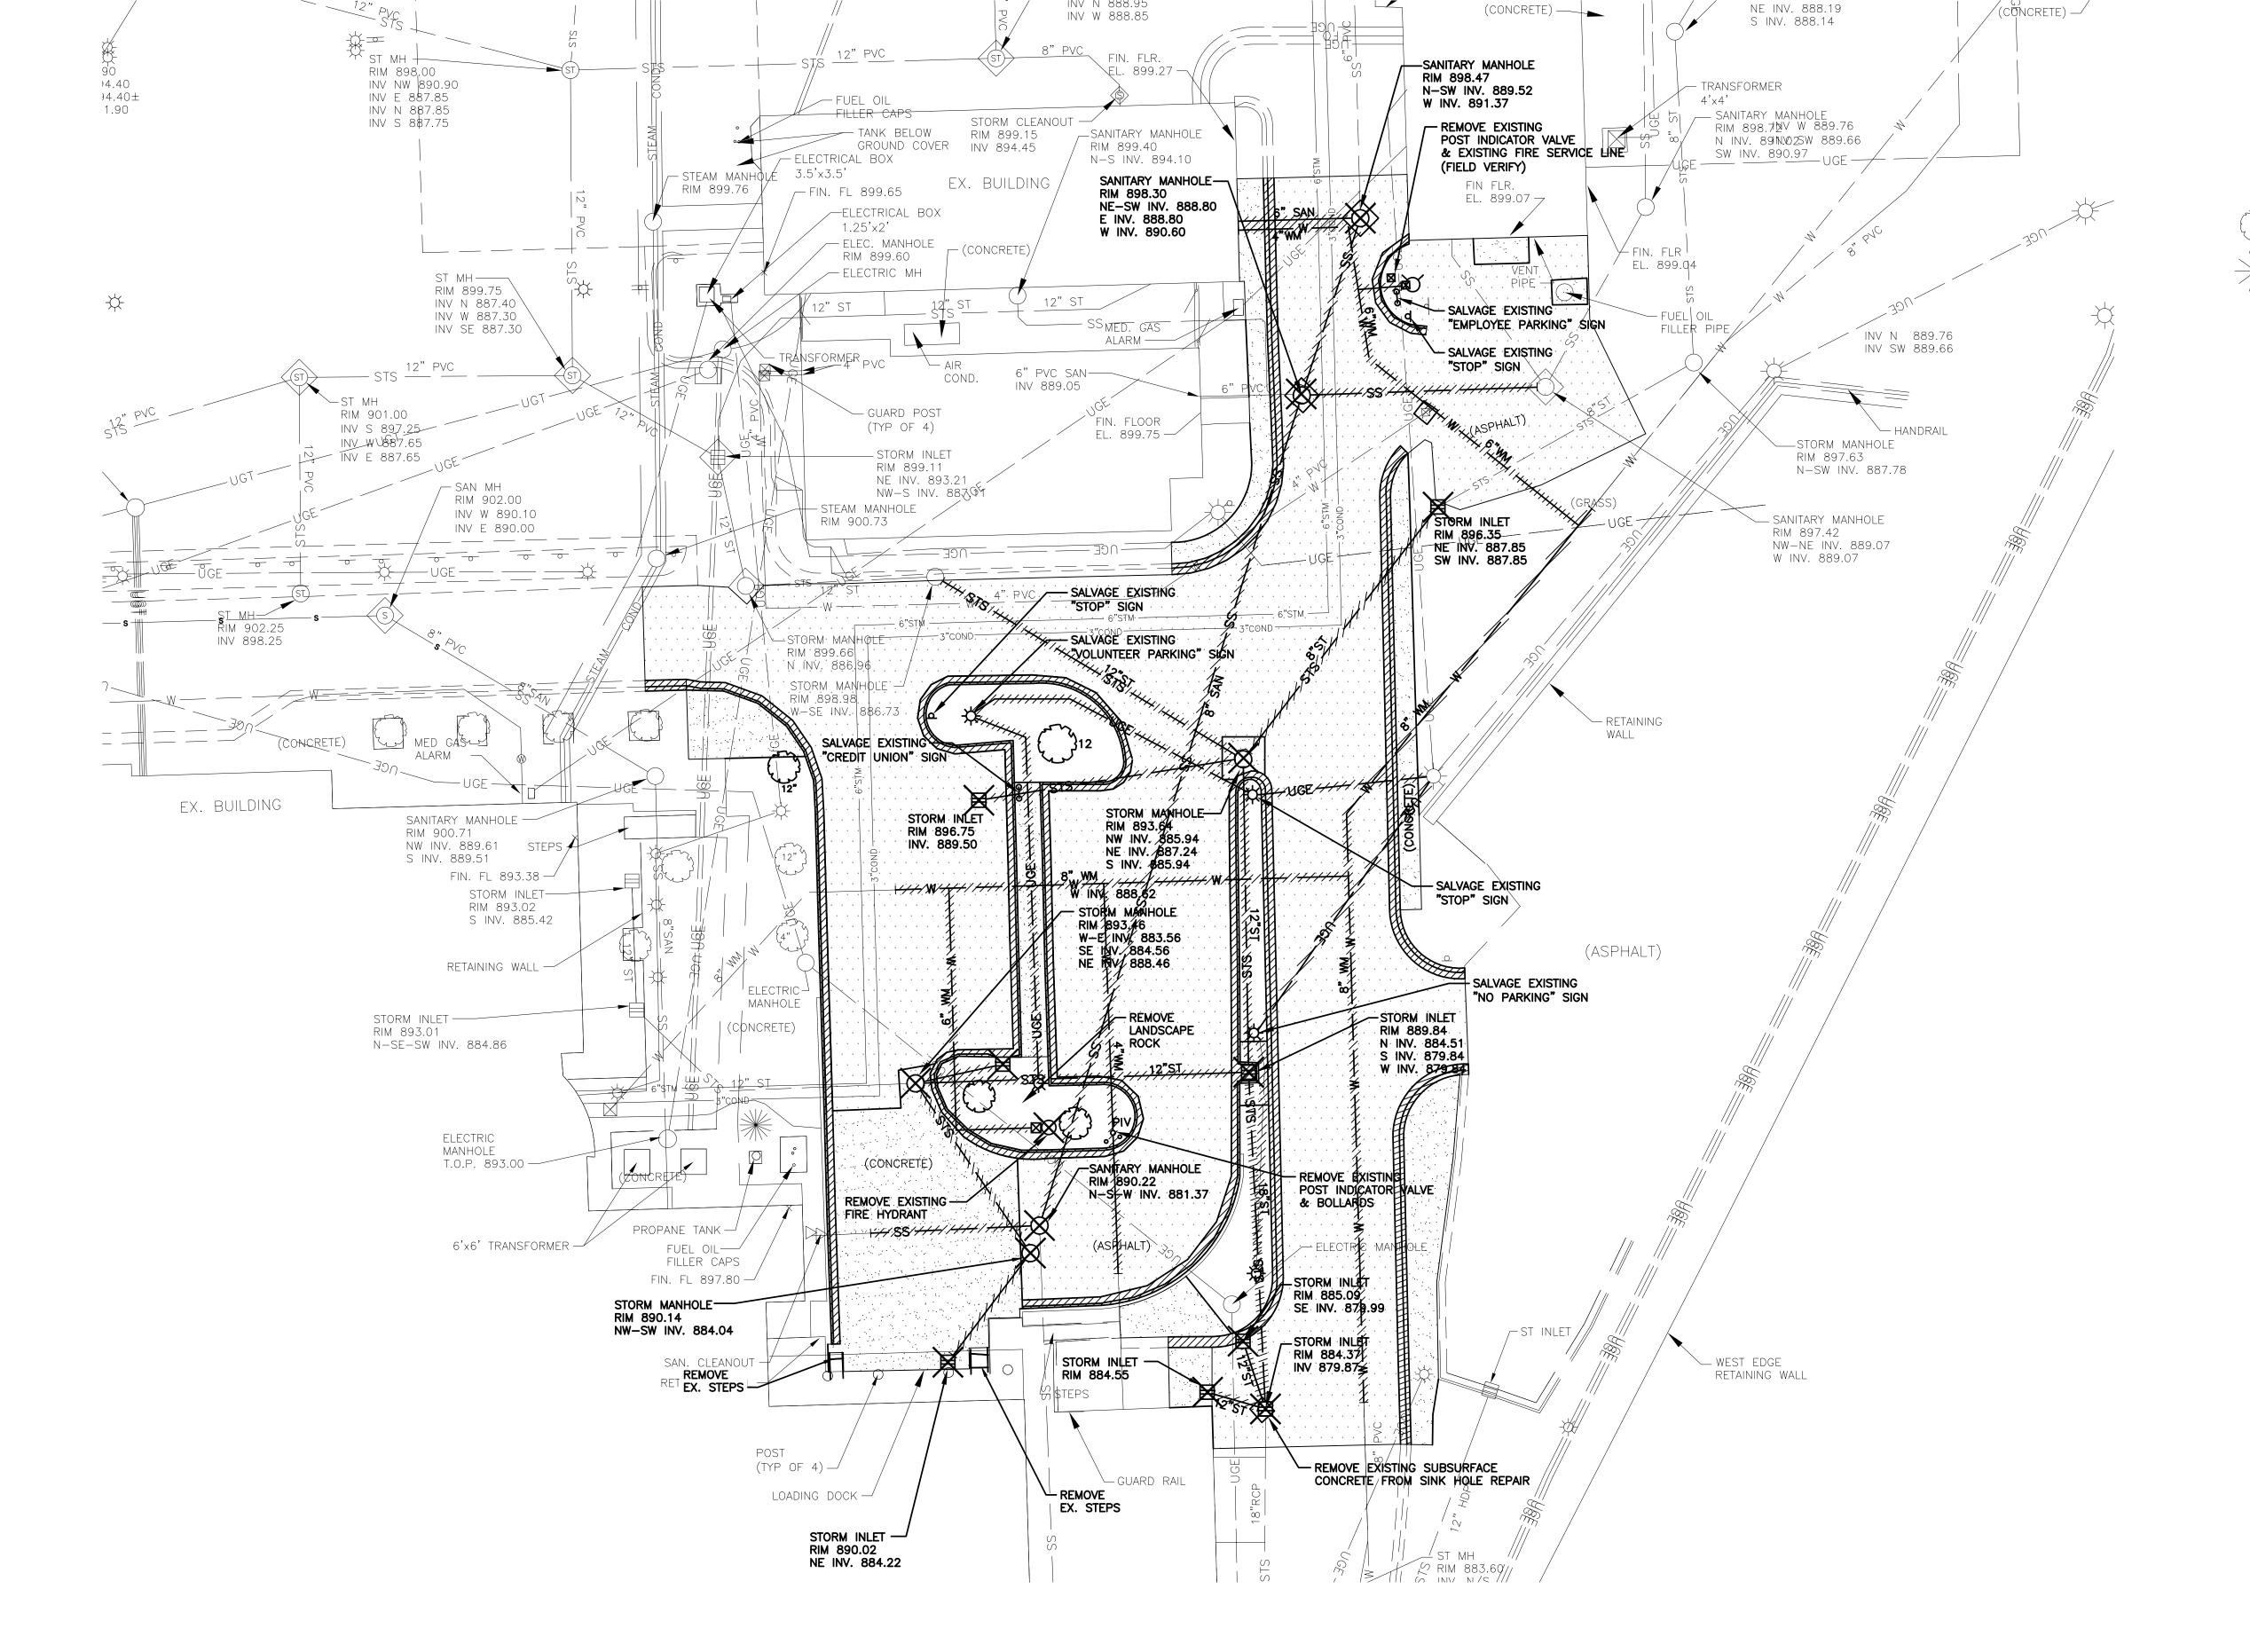
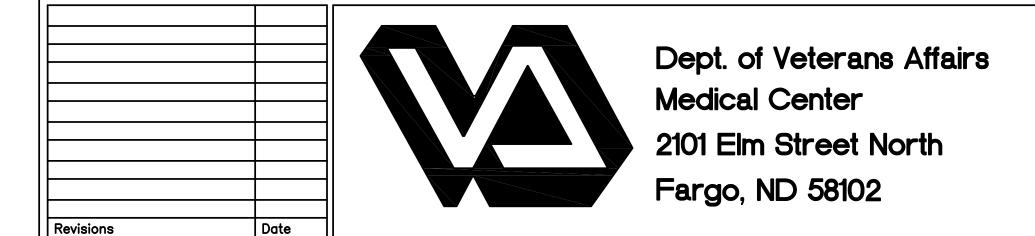


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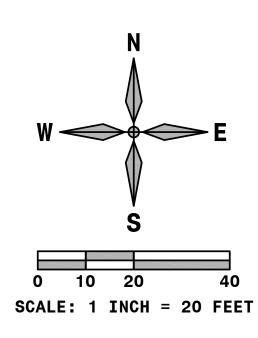




Drawing Title		Project Title			Date
PHASE 5 - DEMOLITION PLAN		∥ va	MEDICAL CEN	NTER	MA
		REPLACE U	TILITY MAINS A	ND ASPHALT	SCALE AS
VA Project No. 437–11–156	Contract No. VA263-P-1217 VA263-C-	Designed By	Checked By JM	Drawn By TE	Drawing
Building No. SITE	AutoCAD File Name 11-110 C5.1.DWG	Location VA	MEDICAL CEN FARGO, ND	NTER	Dwg. 2

MAY 17, 2012 AS NOTED C5.

Dwg. 21 of 45





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	EXISTING MANHOLE	——— UGP ———	EXISTING UNDERGROUND POWER LINE
	EXISTING STORM INLET	————S———	EXISTING SANITARY SEWER LINE
0	EXISTING STORM CLEANOUT	——————————————————————————————————————	EXISTING IRRIGATION LINE
S	EXISTING SANITARY CLEANOUT	———STS———	EXISTING STORM SEWER LINE
E	EXISTING ELECTRIC MANHOLE	———— W ———	EXISTING WATERMAIN LINE
	EXISTING GATE VALVE	CW	EXISTING CHILLED WATER LINE
\nearrow	EXISTING FIRE HYDRANT	——— G ———	EXISTING GAS LINE
- 	EXISTING LIGHT POLE	UGT	EXISTING UNDERGROUND TELEPHONE LINE
	EXISTING TRANSFORMER	OHP	EXISTING OVERHEAD POWER LINE
and the second		TV	EXISTING UNDERGROUND TELEVISION
	EXISTING TREE	——— FO ———	EXISTING UNDERGROUND FIBER OPTIC
	EVICTING TREE	X	EXISTING CHAIN LINK FENCE
	EXISTING TREE		NEW FIRE HYDRANT
	EXISTING SHRUB		NEW GATE VALVE
⊘ ^{PP}	EXISTING POWER POLE	@	NEW POST INDICATOR VALVE
Ø PPR	EXISTING POWER POLE WITH RISER	(S)	NEW SANITARY MANHOLE
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_O TP	EXISTING TELEPHONE PEDESTAL	———w——	NEW WATERMAIN LINE
□TV	EXISTING TELEVISION PEDESTAL	 s	NEW SANITARY LINE
	EXISTING STREET SIGN	st	NEW STORM SEWER LINE
ICV ⊗	EXISTING WATER SERVICE VALVE		
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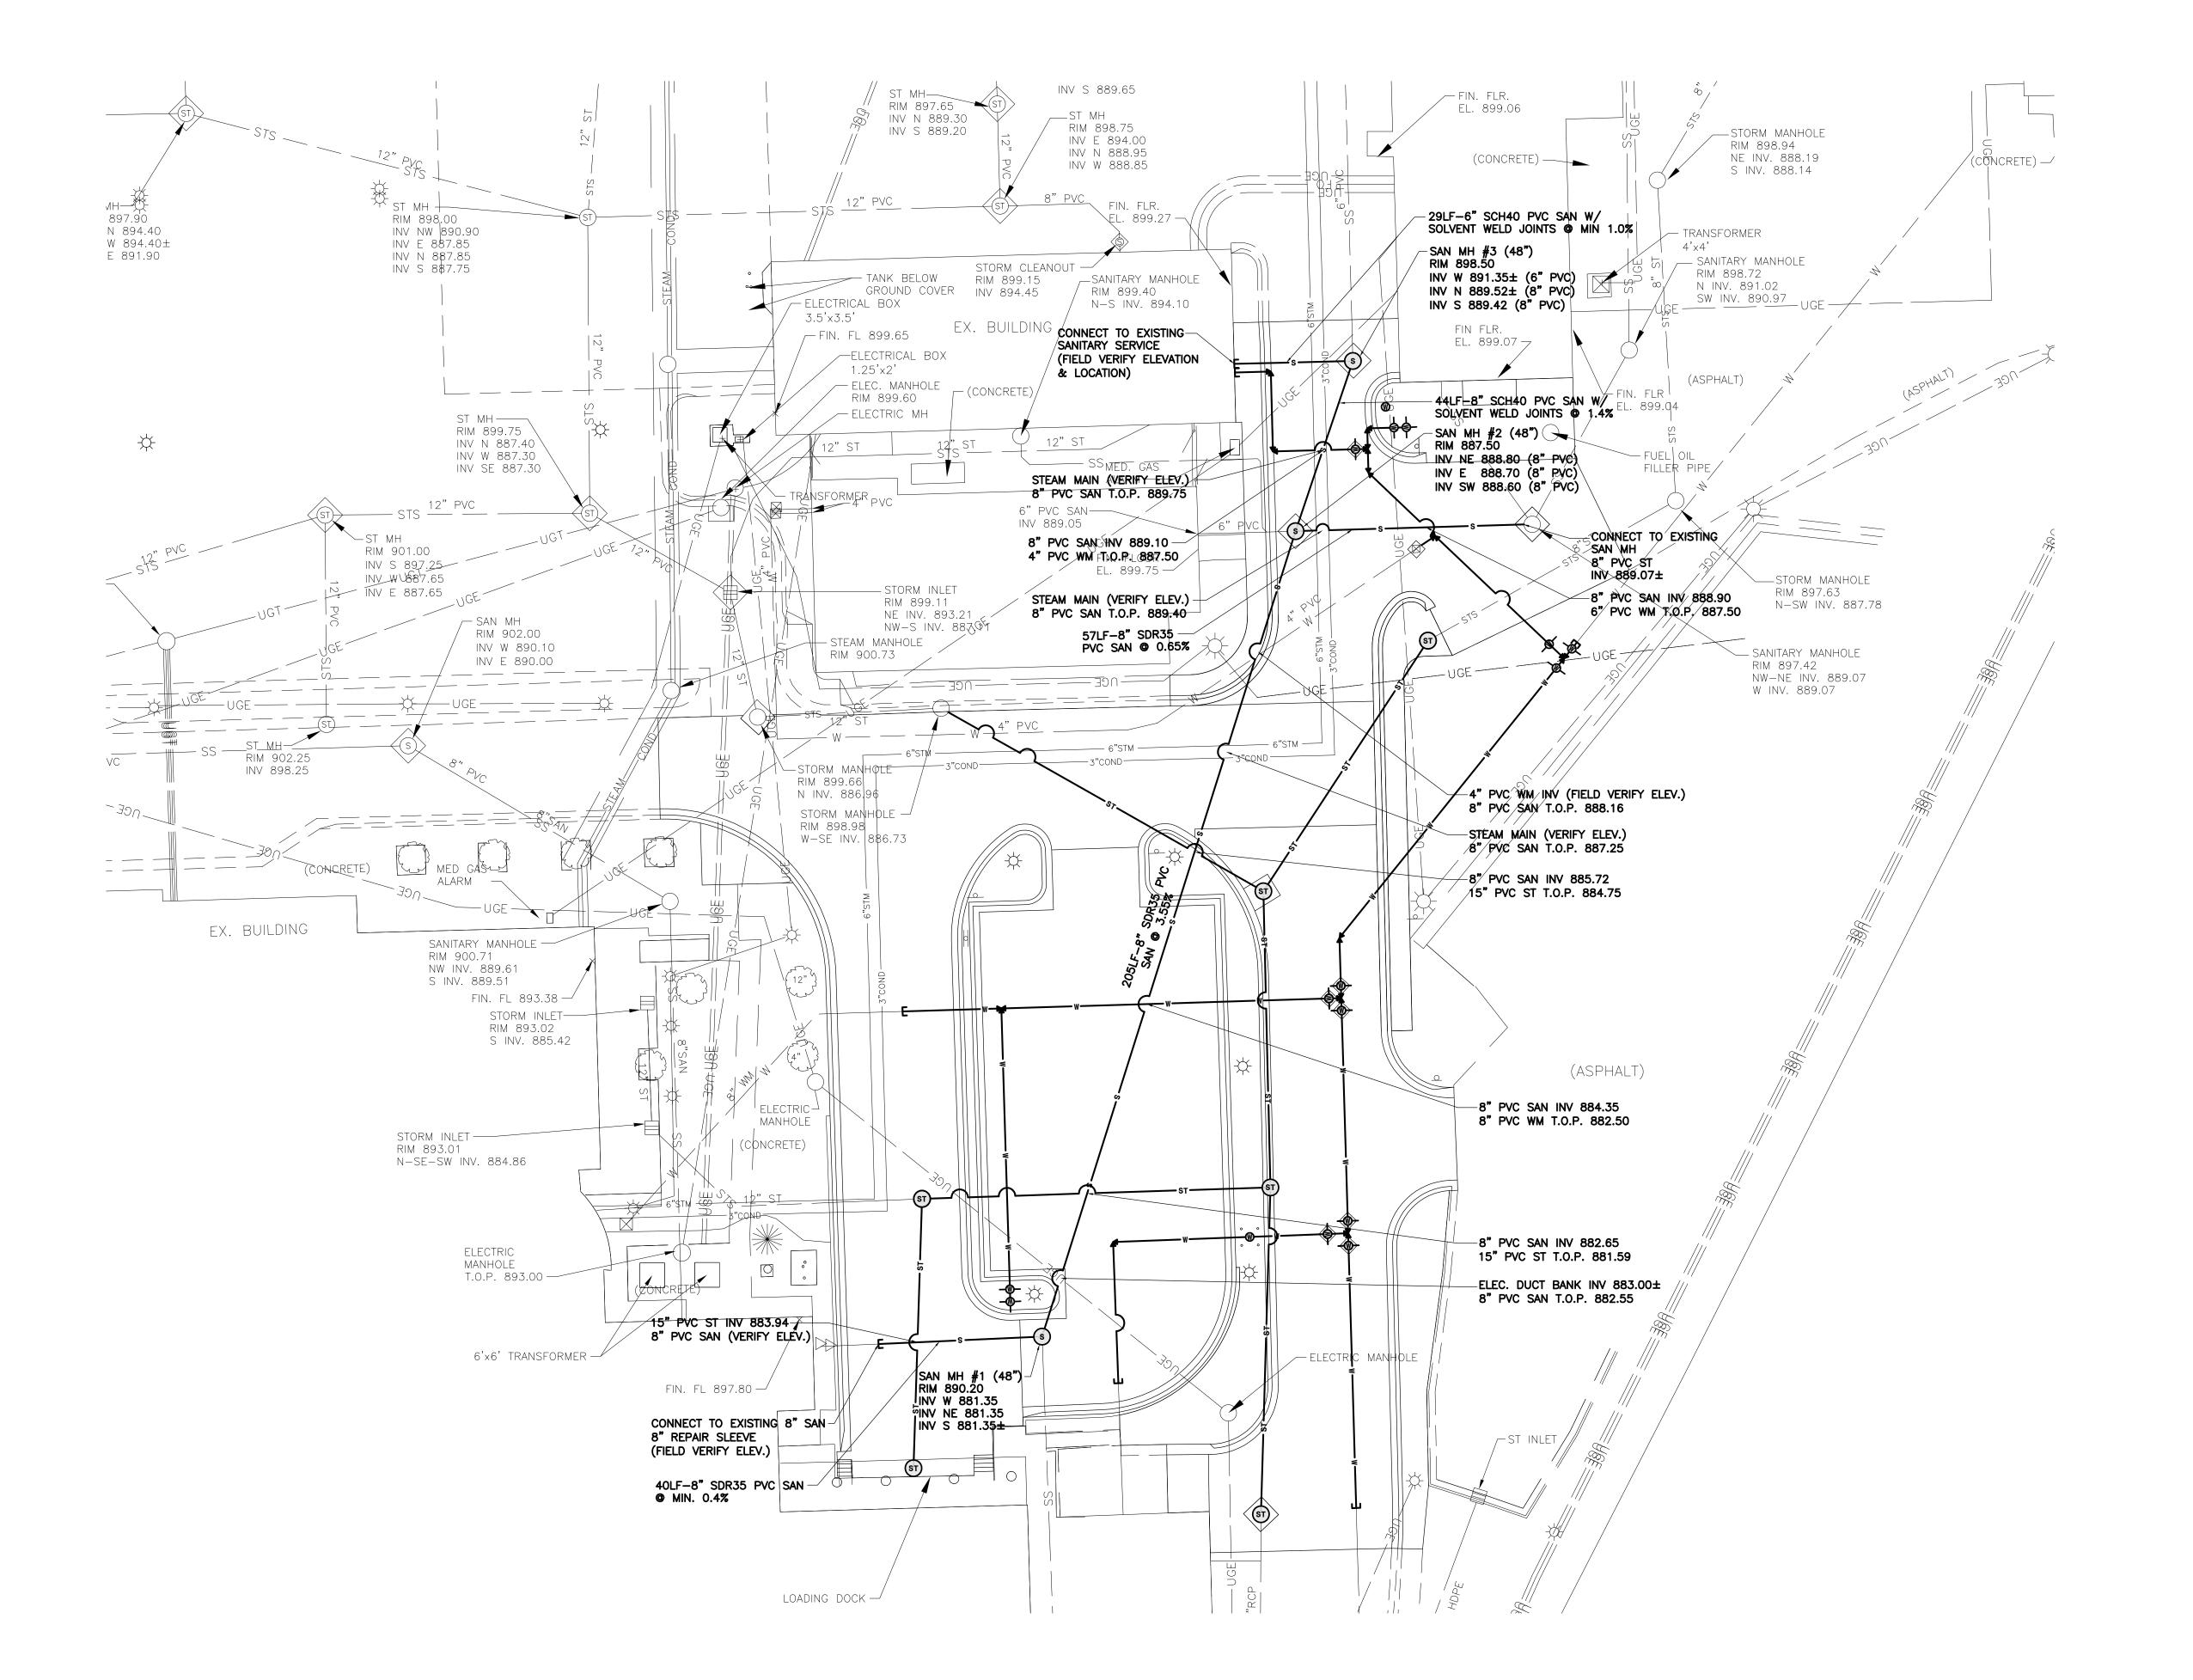
PLAN NOTES:

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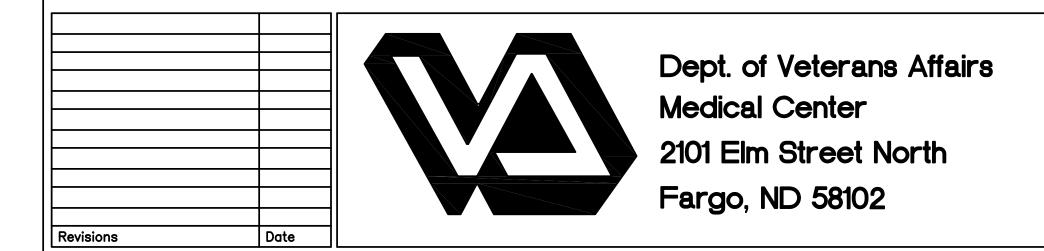




IMAGE GROUP INC., Architecture & Interiors MBN ENGINEERING, Civil Engineers





VA Project No. 437-11-156 Building No.	- UTILITY PLAN ARY SEWER	RE
	Contract No. VA263-P-1217	Desig
437-11-156	VA263-C-	<u> </u>
Building No.	AutoCAD File Name 11-110 C5.2.DWG	Loca

Drawing Title

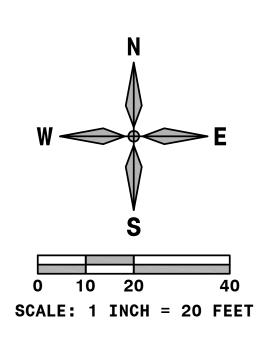
SITE

E 5 - UTILITY PLAN NITARY SEWER		VA MEDICAL CENTER REPLACE UTILITY MAINS AND ASPHALT			
6	Contract No. VA263-P-1217	Designed By			
5	VA263-C-	TE	JM	TE	
	AutoCAD File Name 11-110 C5.2.DWG	Location VA MEDICAL CENTER FARGO, ND		R	

MAY 17, 2012

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Dwg. 22of 45





	EXISTING MANHOLE	UGP	EXISTING UNDERGROUND POWER LINE
	EXISTING STORM INLET	———S———	EXISTING SANITARY SEWER LINE
0	EXISTING STORM CLEANOUT	IRR	EXISTING IRRIGATION LINE
S	EXISTING SANITARY CLEANOUT	———STS———	EXISTING STORM SEWER LINE
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ПТР	EXISTING TELEPHONE PEDESTAL	w	NEW WATERMAIN LINE
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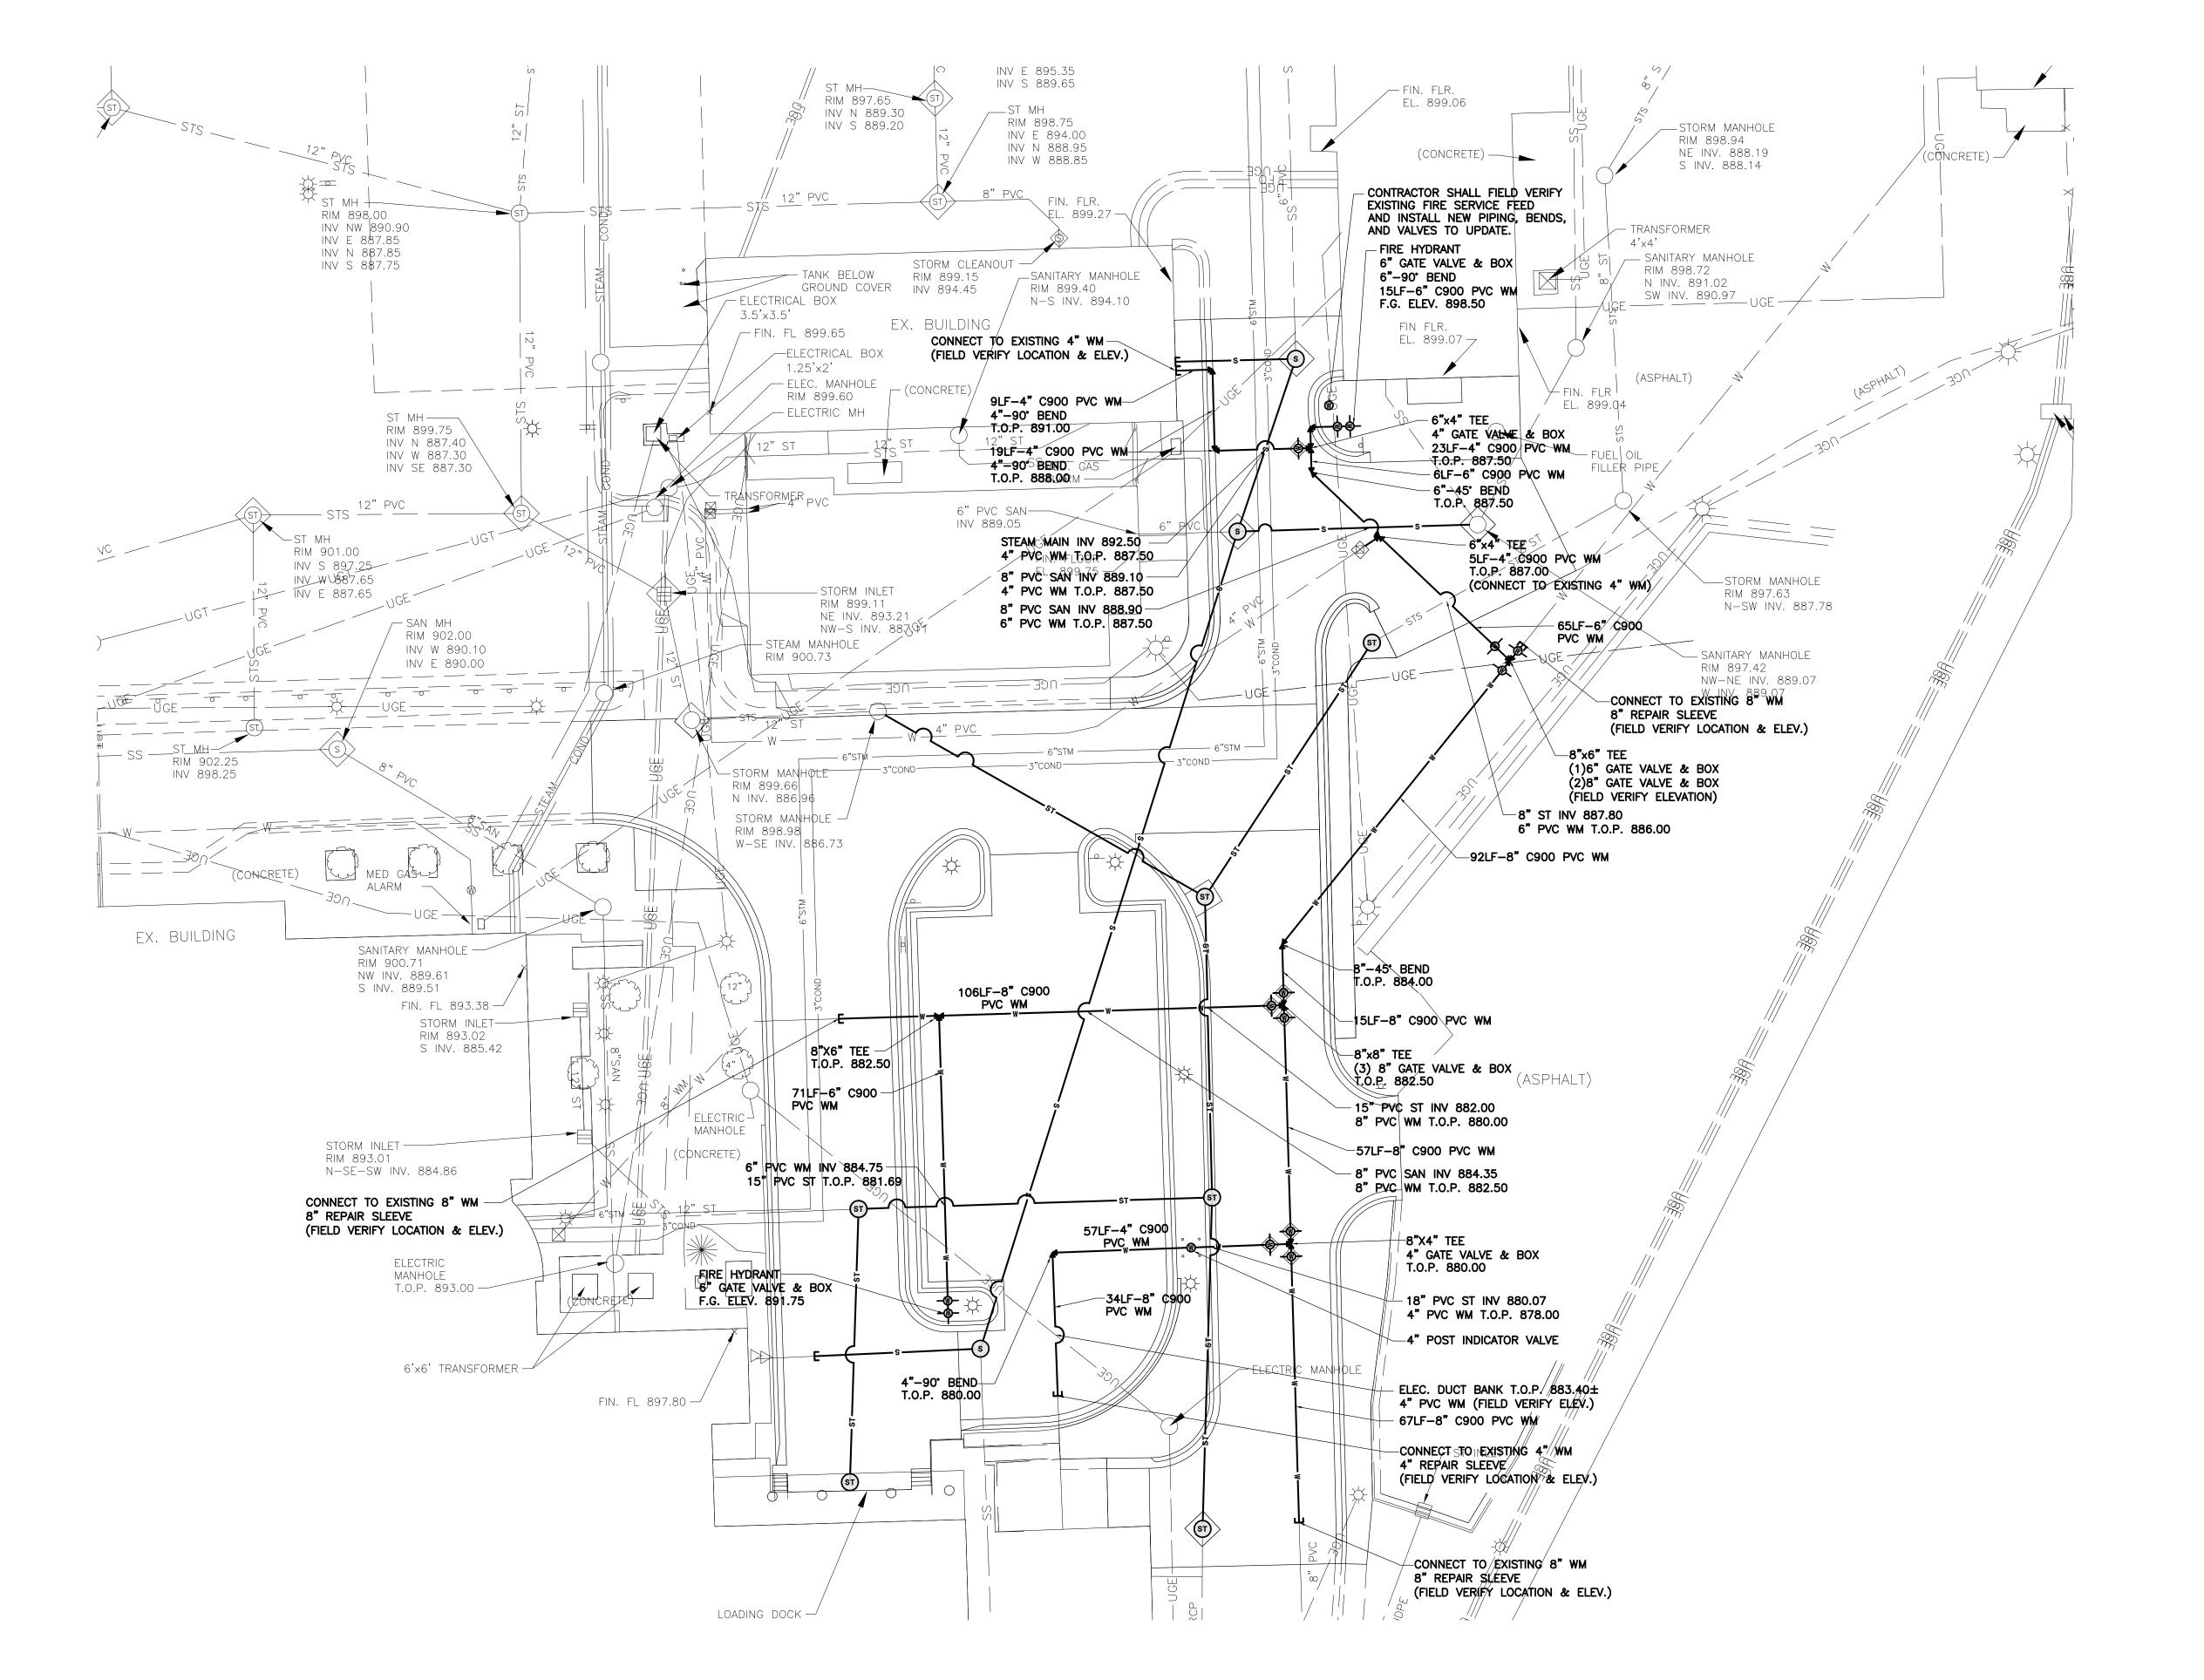
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Project Title

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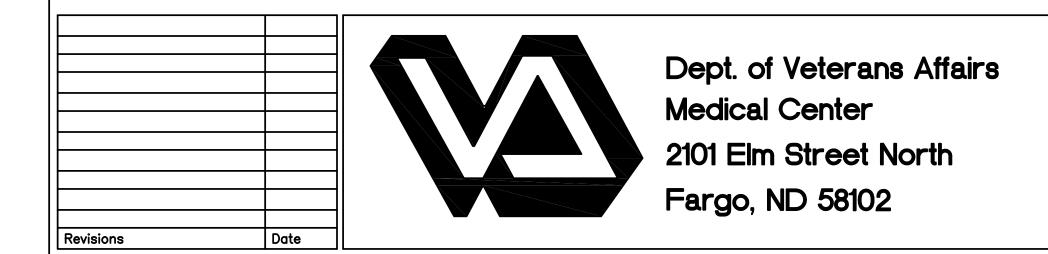




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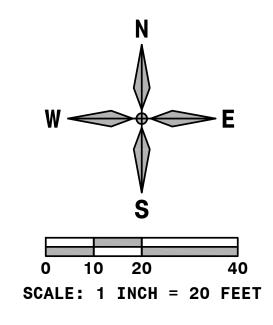




	- UTILITY PLAN TERMAIN	REPL
VA Project No.	Contract No. VA263-P-1217	Designed
437-11-156	VA263-C-	
Building No.	AutoCAD File Name 11-110 C5.3.DWG	Location

Drawing Title

MAY 17, 2012 VA MEDICAL CENTER
LACE UTILITY MAINS AND ASPHALT SCALE AS NOTED Checked By Drawn By TE C5.3 VA MEDICAL CENTER FARGO, ND Dwg. 23 of 45



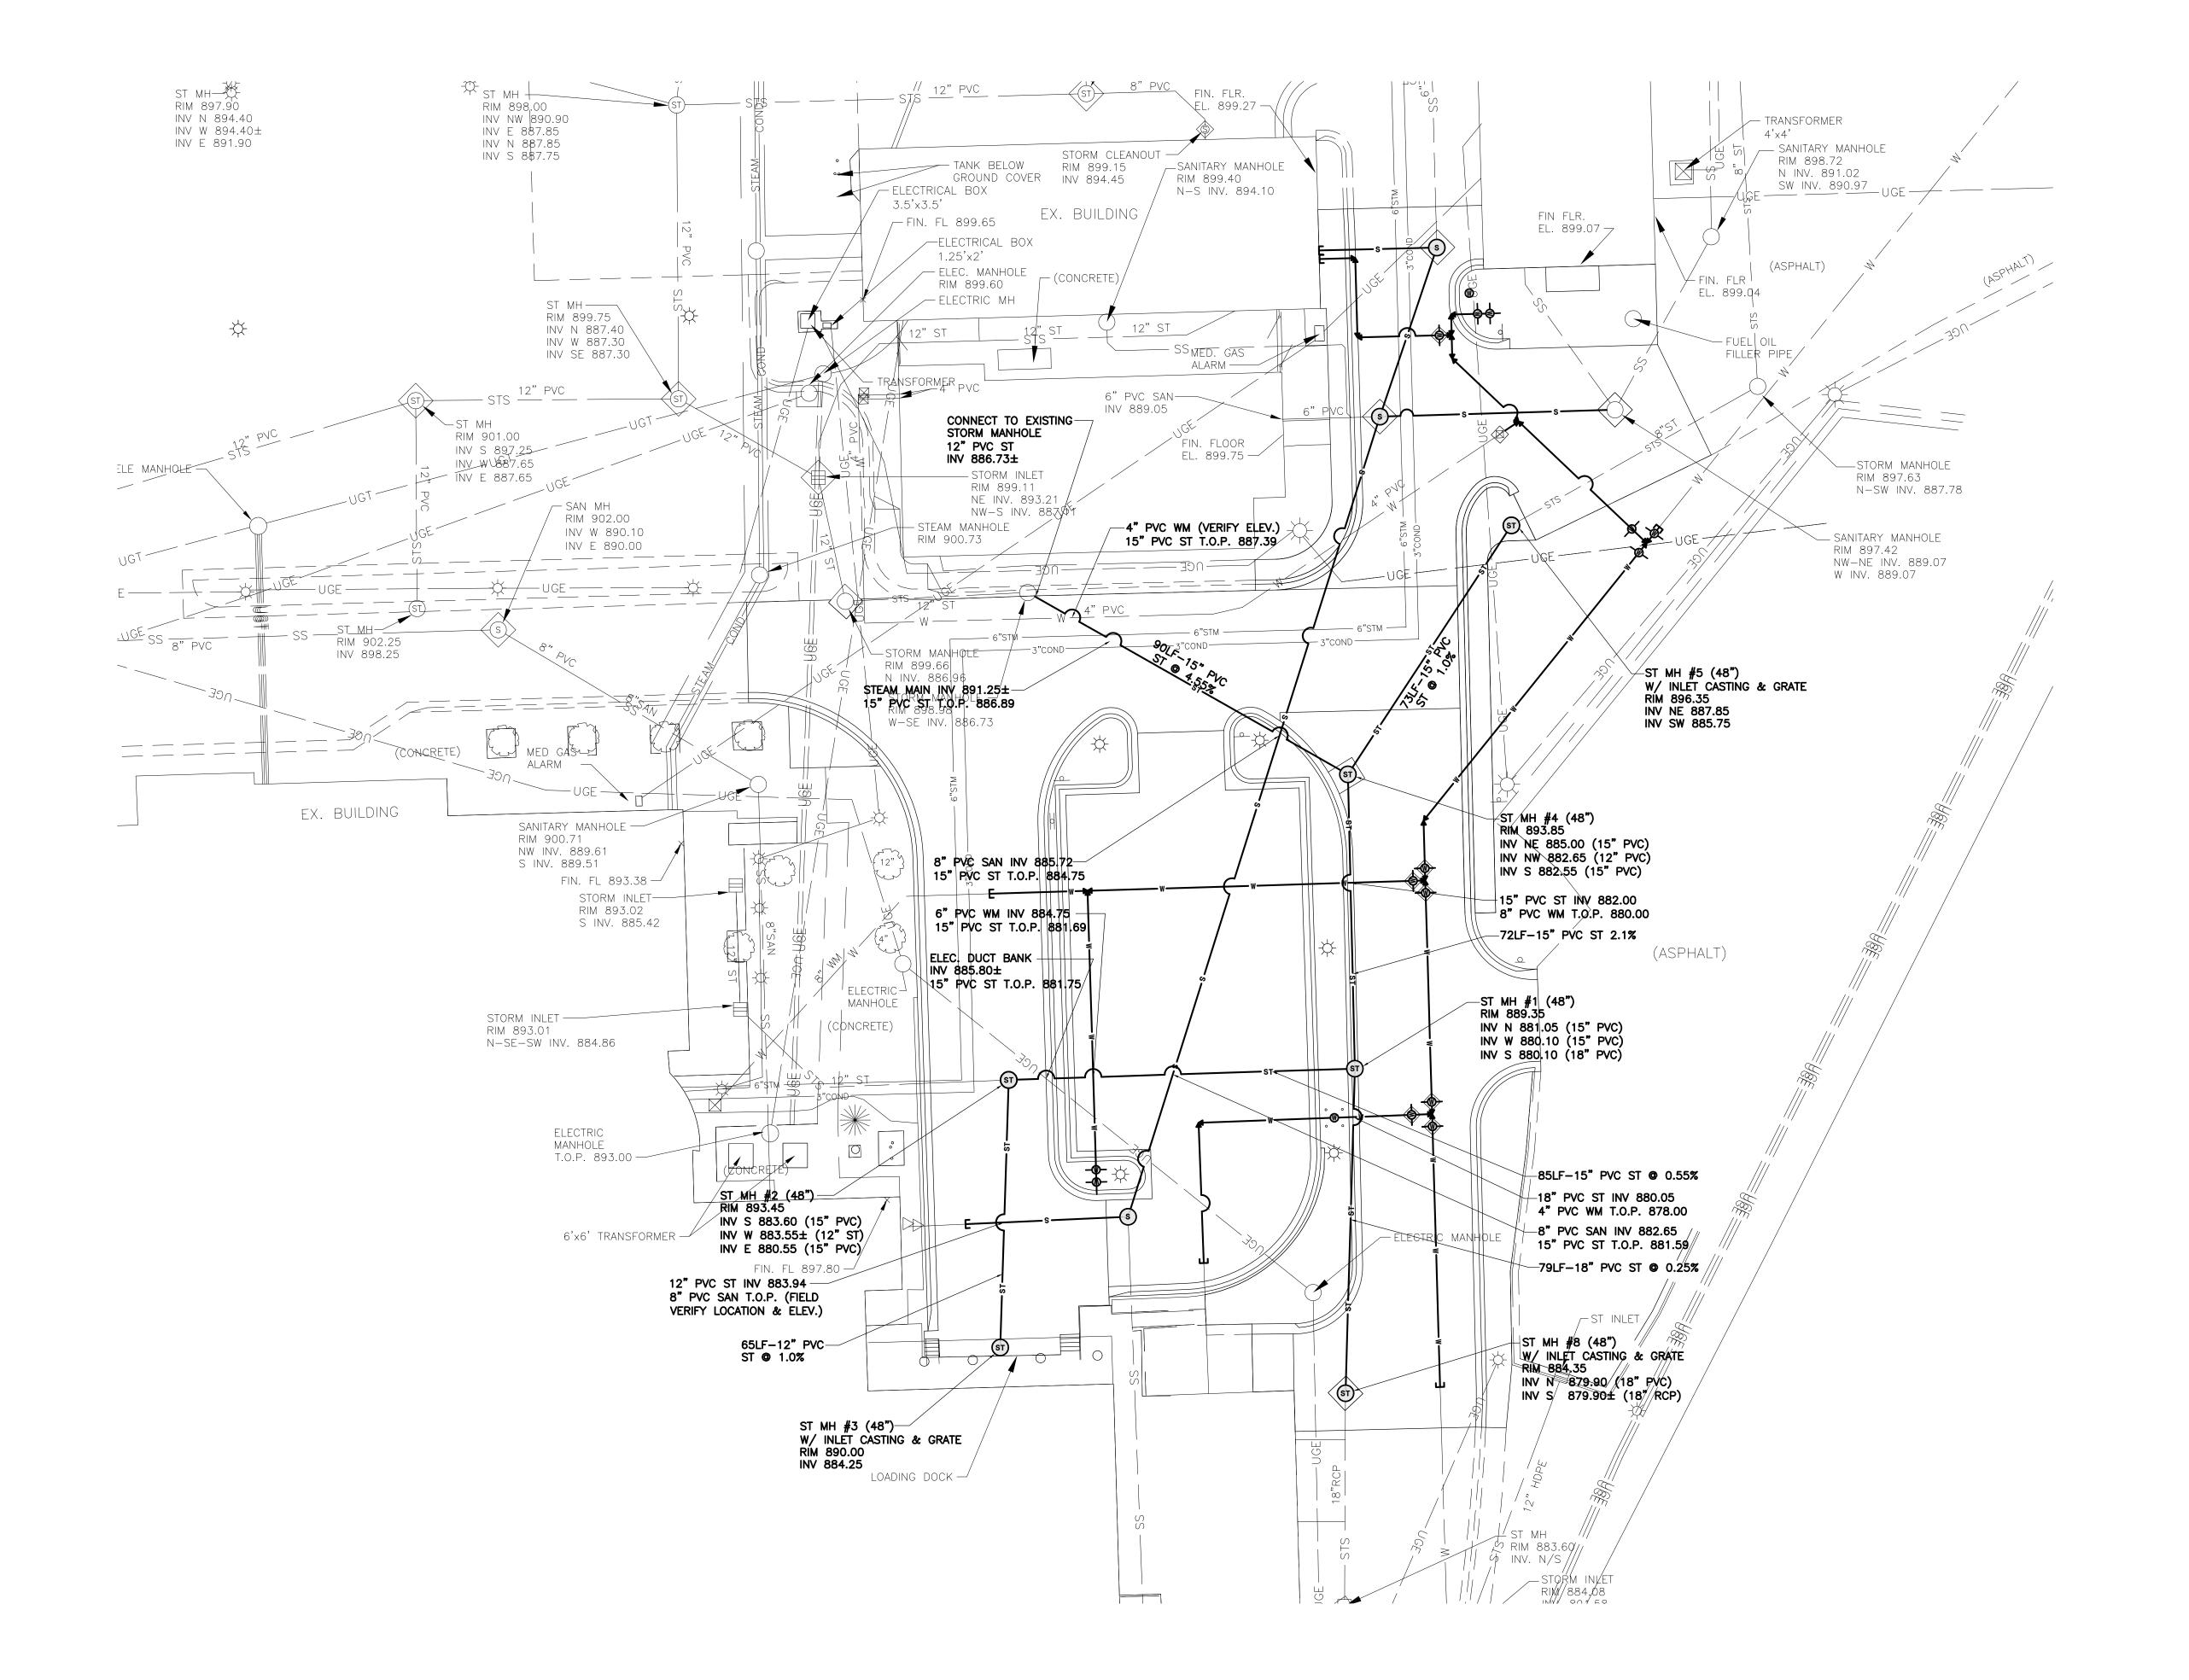


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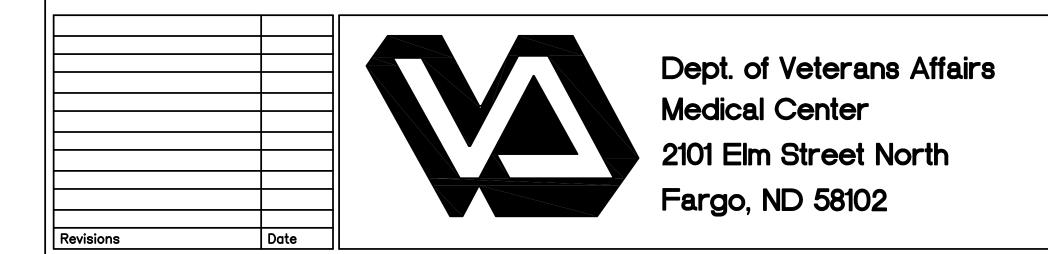




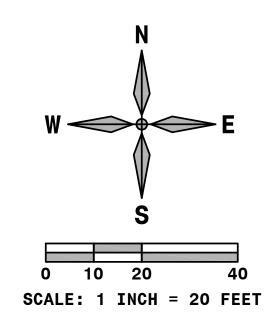
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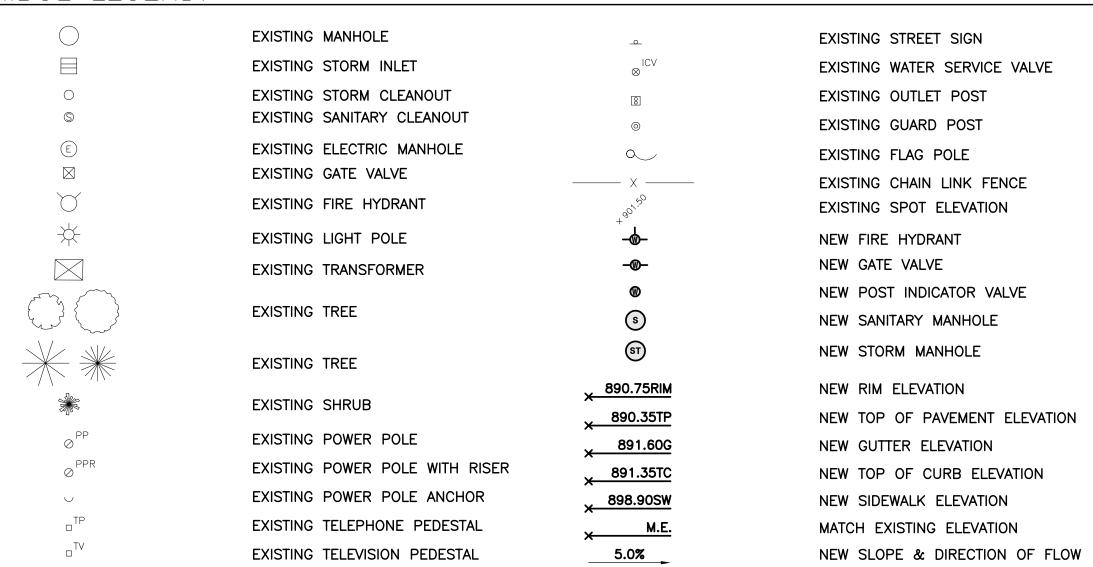


Drawing Title		Project Title	
	- UTILITY PLAN IM SEWER	REPLACE	
VA Project No. 437-11-156	Contract No. VA263-P-1217 VA263-C-	Designed By TE	
Building No.	AutoCAD File Name 11-110 C5.4.DWG	Location V	

	Project Title VA N	MAY 17, 2012		
	REPLACE UT	SCALE AS NOTED		
'	Designed By TE	Checked By JM	Drawn By TE	Drawing No.
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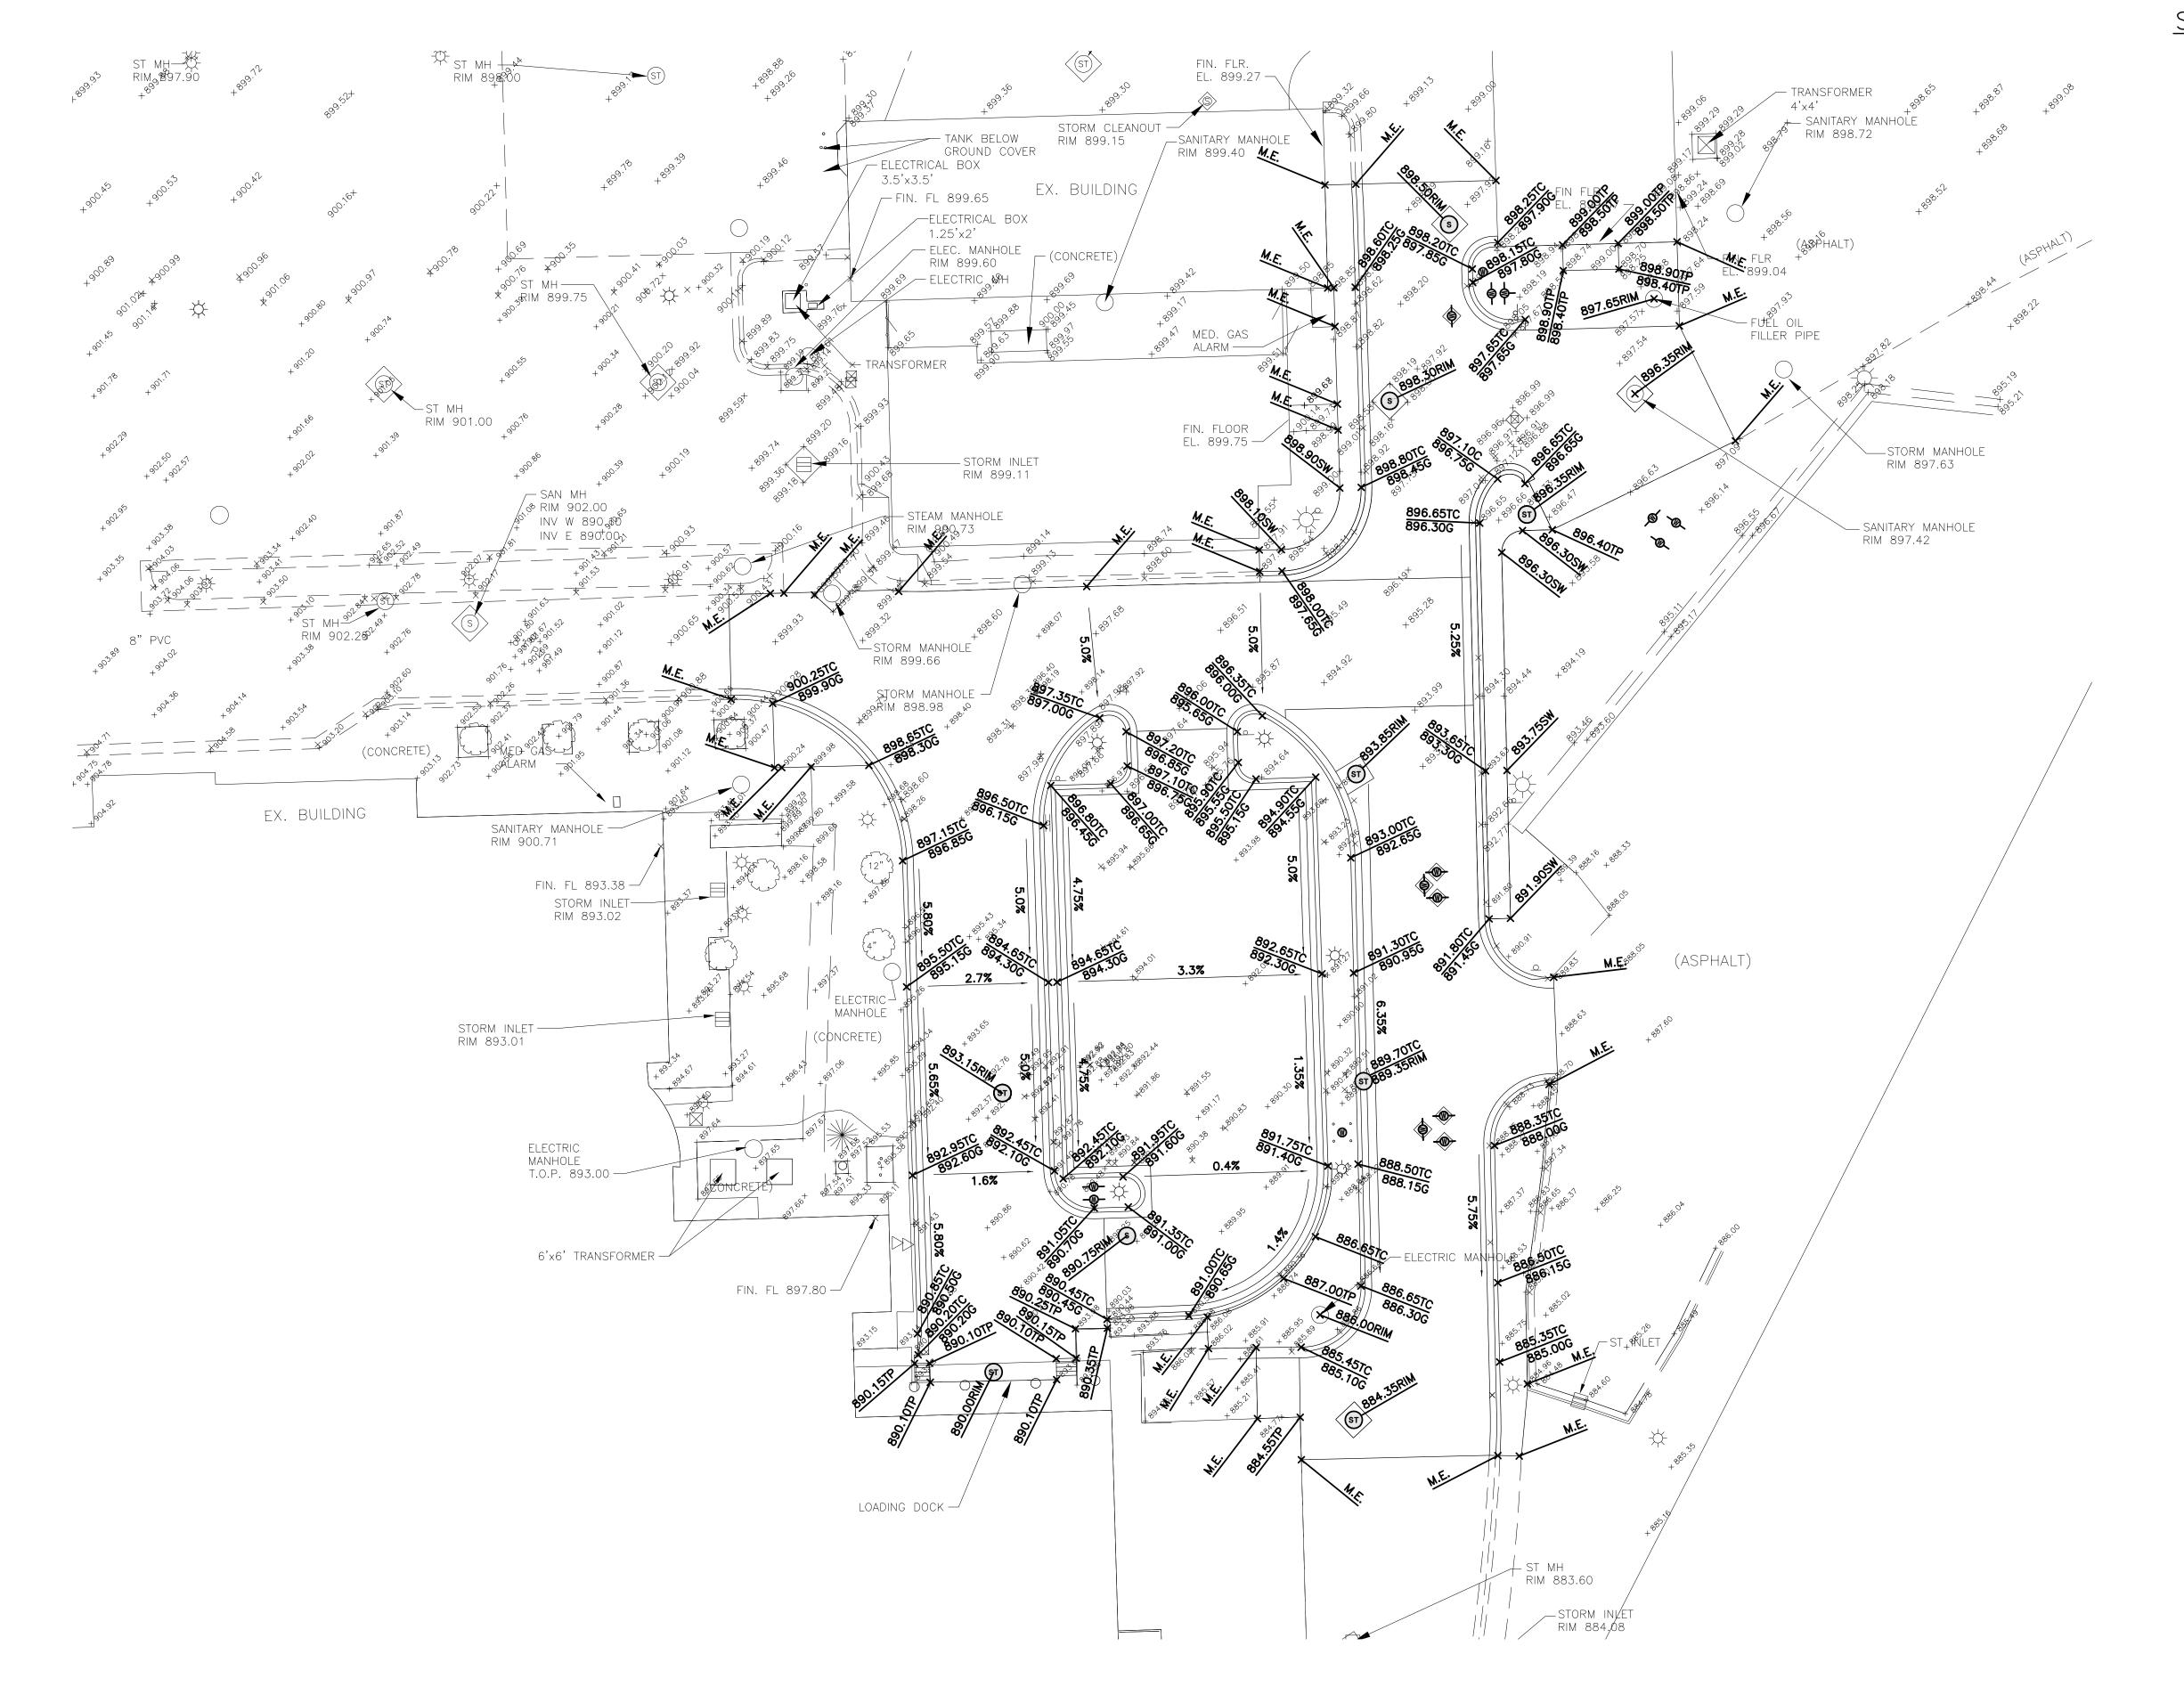




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- 2. CONTRACTOR SHALL FIELD VERIFY LOCATION AND ELEVATION OF ALL EXISTING/PROPOSED UTILITY CROSSINGS, AND WHERE EXISTING UTILITIES CONNECT INTO NEW UTILITY MAINS.
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- 4. CONTRACTOR SHALL KEEP ACCESS OPEN TO ALL EXISTING DOORS, FIRE EXITS, AND LOADING DOCKS DURING ALL PHASES OF CONSTRUCTION. IF TEMPORARY CLOSURES ARE REQUIRED, COORDINATE WITH VA ADMINISTRATION A MINIMUM OF 2 WEEKS IN ADVANCE.
- 5. CONTRACTOR IS REQUIRED TO MAINTAIN ONE DRIVING LANE OPEN AT ALL TIMES. IF ROAD CLOSURE IS REQUIRED, COORDINATE WITH VA ADMINISTRATION A MINIMUM OF 2 WEEKS IN ADVANCE.
- 6. CONTRACTOR IS RESPONSIBLE FOR GENERAL TRAFFIC CONTROL TO ALLOW FOR PUBLIC ACCESS THROUGH THE PROJECT SITE, CONTRACTOR SHALL PROVIDE ADEQUATE SIGNS FOR PUBLIC SAFETY AND TRAFFIC CONTROL. CONTRACTOR IS RESPONSIBLE TO KEEP ACCESS TO THE EAST & NORTH LOADING DOCK OPEN FOR DAILY DELIVERIES & COORDINATE ANY RESTRICTIONS WITH THE VA ADMINISTRATION.
- 7. CONTRACTOR SHALL MAINTAIN 7.5' BURY DEPTH OVER ALL NEW WATERMAIN.
- 8. CONTRACTOR SHALL PROTECT THE EXISTING WATERMAIN AND ENSURE THAT VA MEDICAL CAMPUS HAS NO DISRUPTION OF SERVICE. NEW WATERMAIN SHALL BE INSTALLED AND OPERATIONAL BEFORE ANY DISCONNECTION OF EXISTING WATER SERVICE. COORDINATE ANY REQUIRED LOSS OF SERVICE WITH VA ADMINISTRATION PRIOR TO WORK.
- 9. CONTRACTOR WILL BE RESPONSIBLE FOR PROVIDING A TEMPORARY WATER SERVICE TO THE AFFECTED VA BUILDINGS. THE METHOD OF PROVIDING THE TEMPORARY WATER SERVICE SHALL BE AN OPTION OF THE CONTRACTOR SUBJECT TO THE APPROVAL OF THE ENGINEER. ALL TEMPORARY WATER MAINS AND SERVICES SHALL BE DISINFECTED IN ACCORDANCE WITH THE SPECIFICATIONS. ONE WATER SAMPLE PER SERVICE CONNECTION WILL BE TAKEN AFTER THE TEMPORARY WATER LINE IS FLUSHED. THE SAMPLE SHALL SHOW THE ABSENCE OF BACTERIA BEFORE CONNECTIONS ARE ALLOWED.
- 10. THE CONTRACTOR SHALL INSTALL A TEMPORARY BYPASS TO MAINTAIN UNINTERRUPTED SEWER SERVICE ON SEWER RECONSTRUCTION WHERE WORK WILL INTERFERE WITH SEWAGE FLOW IN THE EXISTING SEWER. THE BYPASS SHALL BE MADE BY DIVERTING THE EFFLUENT FLOW AT AN UPSTREAM ACCESS MANHOLE AND PUMPING IT THROUGH A SEPARATE CONDUIT TO A DOWNSTREAM REENTRY POINT OR TO AN ADJACENT SEWER SYSTEM. THE PUMP AND BYPASS CONDUIT SHALL BE OF ADEQUATE SIZE AND CAPACITY TO HANDLE THE FLOW. THE EFFLUENT LEVEL IN THE BYPASS PUMPING MANHOLE SHALL NOT BE ALLOWED TO RISE MORE THAN 1 FOOT ABOVE THE CROWN OF THE INCOMING SEWER PIPE. BYPASS PUMPING SHALL BE INCIDENTAL TO THE SEWER WORK.
- 11. CONTRACTOR SHALL PROVIDE AND INSTALL ANY ADDITIONAL FITTINGS, PIPING, AND OFFSETS TO ACCOUNT FOR UTILITY LOCATIONS AND CROSSINGS NOT INDICATED ON THE PLANS.
- 12. CONTRACTOR SHALL RELOCATE ANY EXISTING UTILITIES THAT CONFLICT WITH THE INSTALLATION OF THE NEW SANITARY SEWER, STORM SEWER, AND WATERMAIN. ADDITIONAL WORK AND MATERIALS SHALL BE INSTALLED AT NO COST TO THE PROJECT.
- 13. ALL GRASSED AREAS DISTURBED BY CONSTRUCTION SHALL HAVE TOPSOIL (6" DEPTH), GRADED, SEEDED, AND HYDRO-MULCHED.

BENCHMARKS:

- 1. BM #1: THE SOUTHEAST FLANGE BOLT OF THE FIRE HYDRANT LOCATED IN THE NORTHWEST CORNER OF THE INTERSECTION OF ELM STREET & 21ST AVENUE NORTH. ELEVATION = 902.46 (NAVD 88)
- 2. BM#2: THE SOUTHEAST FLANGE BOLT OF THE FIRE HYDRANT LOCATED IN THE SOUTH PARKING LOT. ELEVATION = 891.74 (NAVD 88)



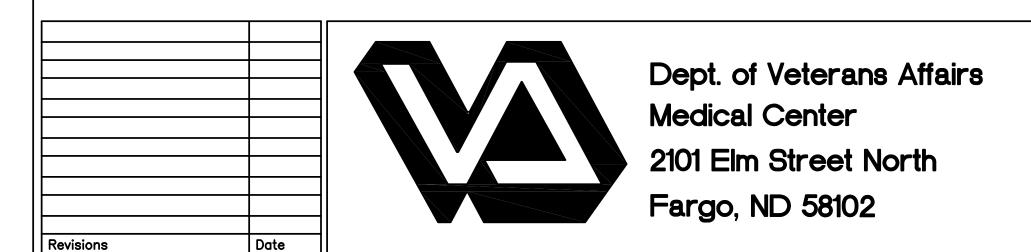




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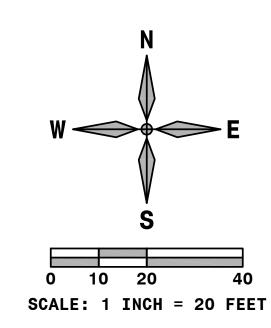
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PHASE 5 -	GRADING PLAN		A MEDICAL CEN JTILITY MAINS A		SCI
VA Project No. 437–11–156	Contract No. VA263-P-1217 VA263-C-	Designed By	Checked By JM	Drawn By	De
Building No. SITE	AutoCAD File Name 11-110 C5.5.DWG	Location VA	A MEDICAL CEN FARGO, ND	NTER	

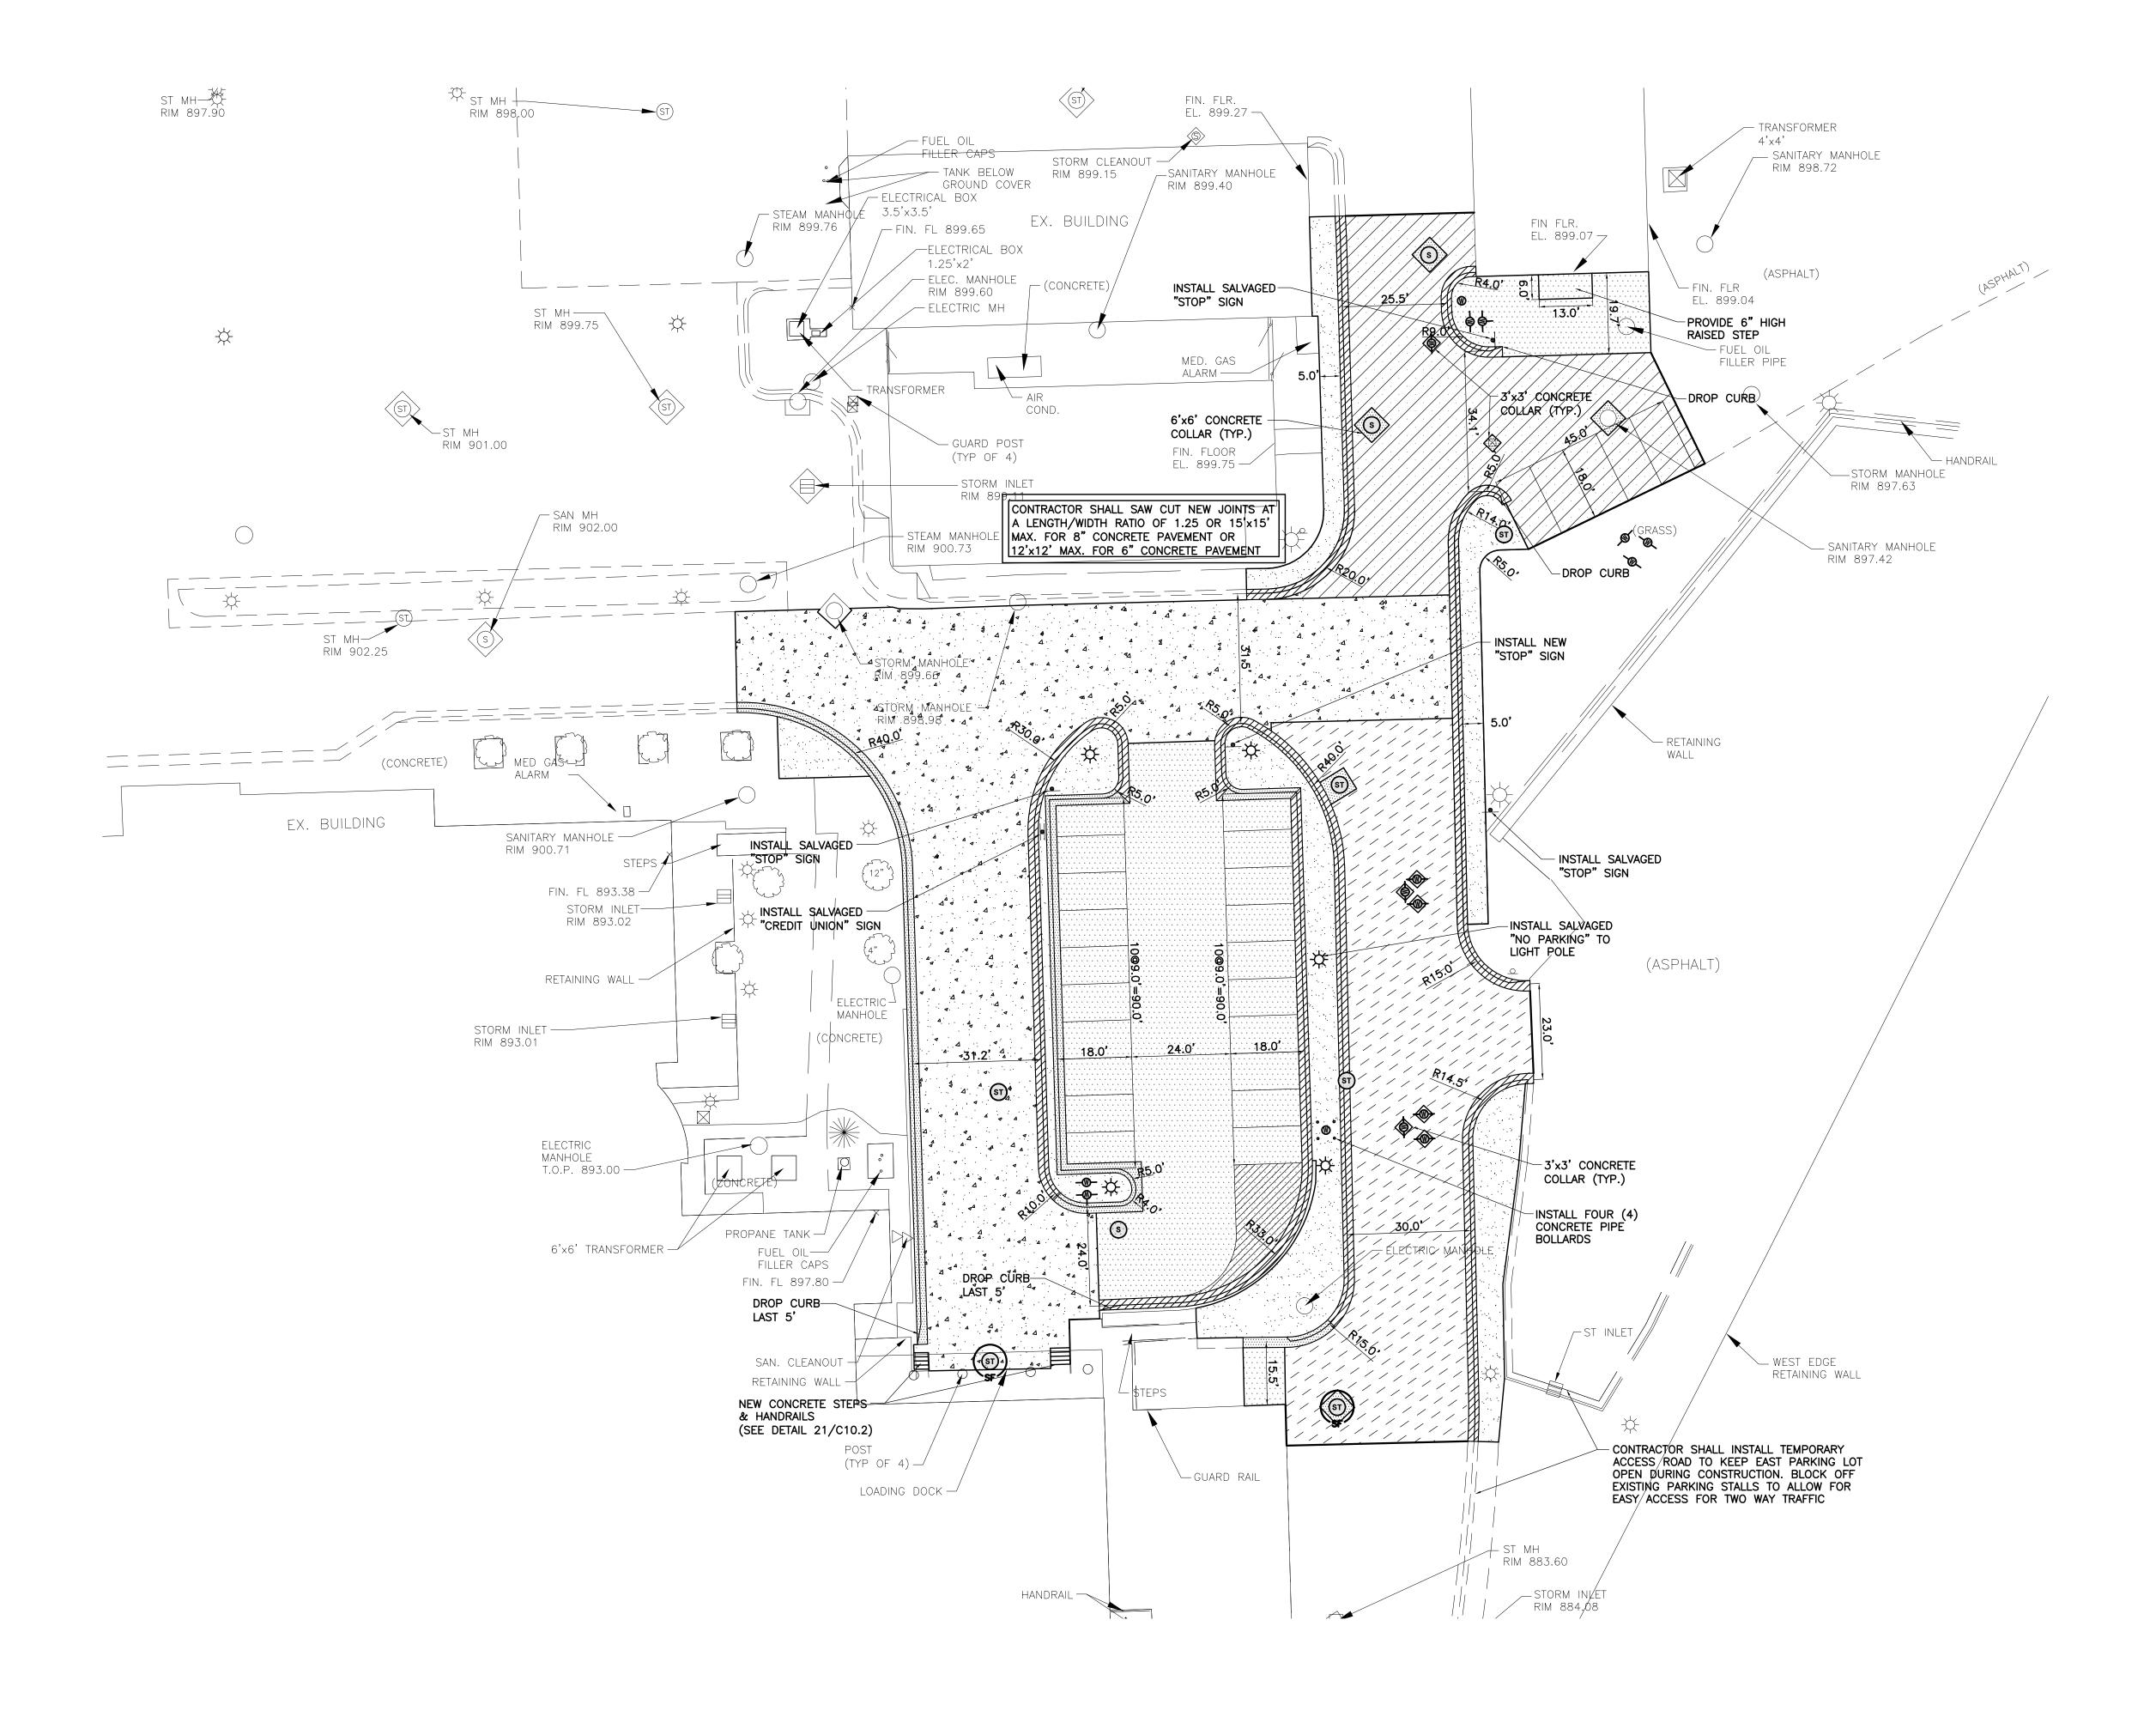
VA MEDICAL CENTER FARGO, ND

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SYMBOL LEGEND:

	EXISTING MANHOLE	8	EXISTING OUTLET POST
	EXISTING STORM INLET	<u> </u>	EXISTING GUARD POST
O (\$	EXISTING STORM CLEANOUT EXISTING SANITARY CLEANOUT	0_	EXISTING FLAG POLE
(E) ⊠	EXISTING ELECTRIC MANHOLE EXISTING GATE VALVE	×	EXISTING CHAIN LINK FENCE NEW FIRE HYDRANT
	EXISTING GATE VALVE EXISTING FIRE HYDRANT		NEW GATE VALVE NEW POST INDICATOR VALVE
*	EXISTING LIGHT POLE	<u>(S)</u>	NEW SANITARY MANHOLE
	EXISTING TRANSFORMER	(ST)	NEW STORM MANHOLE
3	EXISTING TREE		NEW 4" REINFORCED CONCRETE SIDEWALK
*************************************	EXISTING TREE		NEW 6" ASPHALT PAVEMENT NEW 9" ASPHALT PAVEMENT
	EXISTING SHRUB		NEW 6" CONCRETE PAVEMENT
PP ⊘	EXISTING POWER POLE	4	NEW 8" REINFORCED CONCRETE PAVEMENT
⊘ PPR ○	EXISTING POWER POLE WITH RISER EXISTING POWER POLE ANCHOR		NEW TYPE I MOUNTABLE CURB & GUTTER
ПР	EXISTING TELEPHONE PEDESTAL		NEW TYPE II MOUNTABLE CURB & GUTTER
_TV	EXISTING TELEVISION PEDESTAL EXISTING STREET SIGN	(ST) SF	NEW INLET PROTECTION
ICV ⊗	EXISTING WATER SERVICE VALVE	*	SALVAGED LIGHT POLE

PLAN NOTES:

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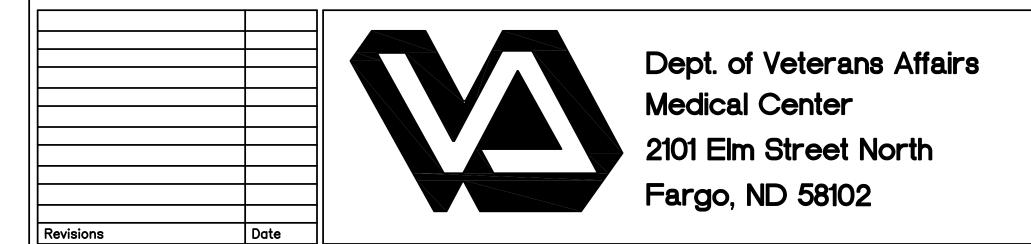




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Drawing Title		Project Title	
	PAVING PLAN, CONTROL PLAN	VA MEDICAL CEN REPLACE UTILITY MAINS A	
VA Project No. 437-11-156	Contract No. VA263-P-1217 VA263-C-	Designed By	Checked By JM

AutoCAD File Name 11-110 C5.6.DWG

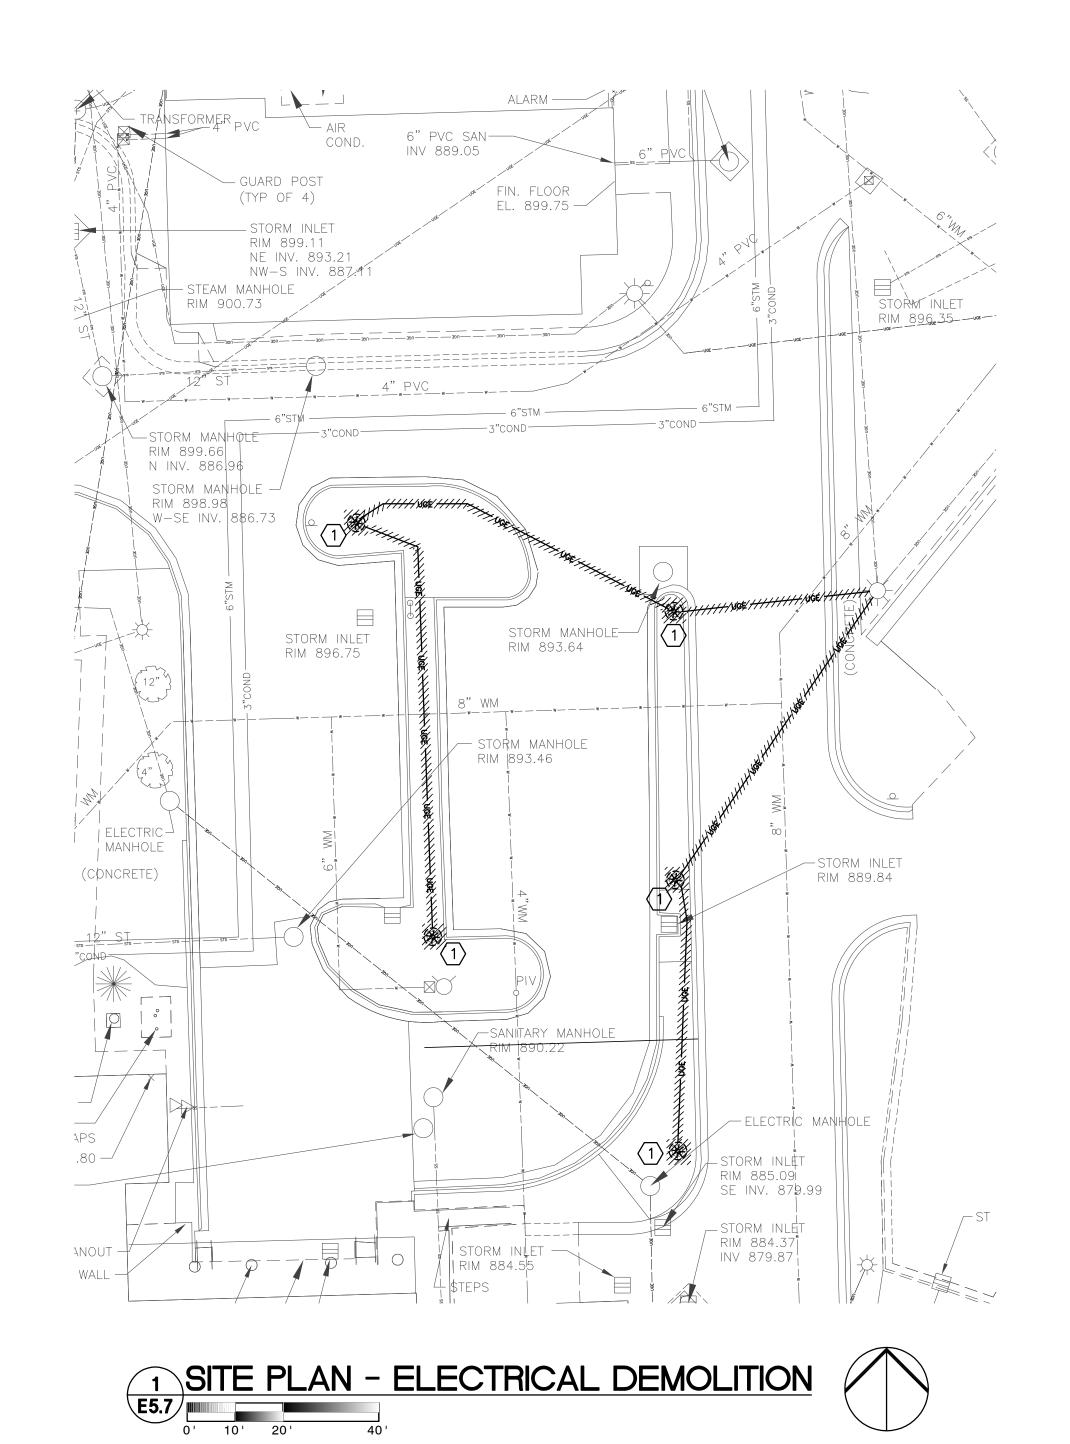
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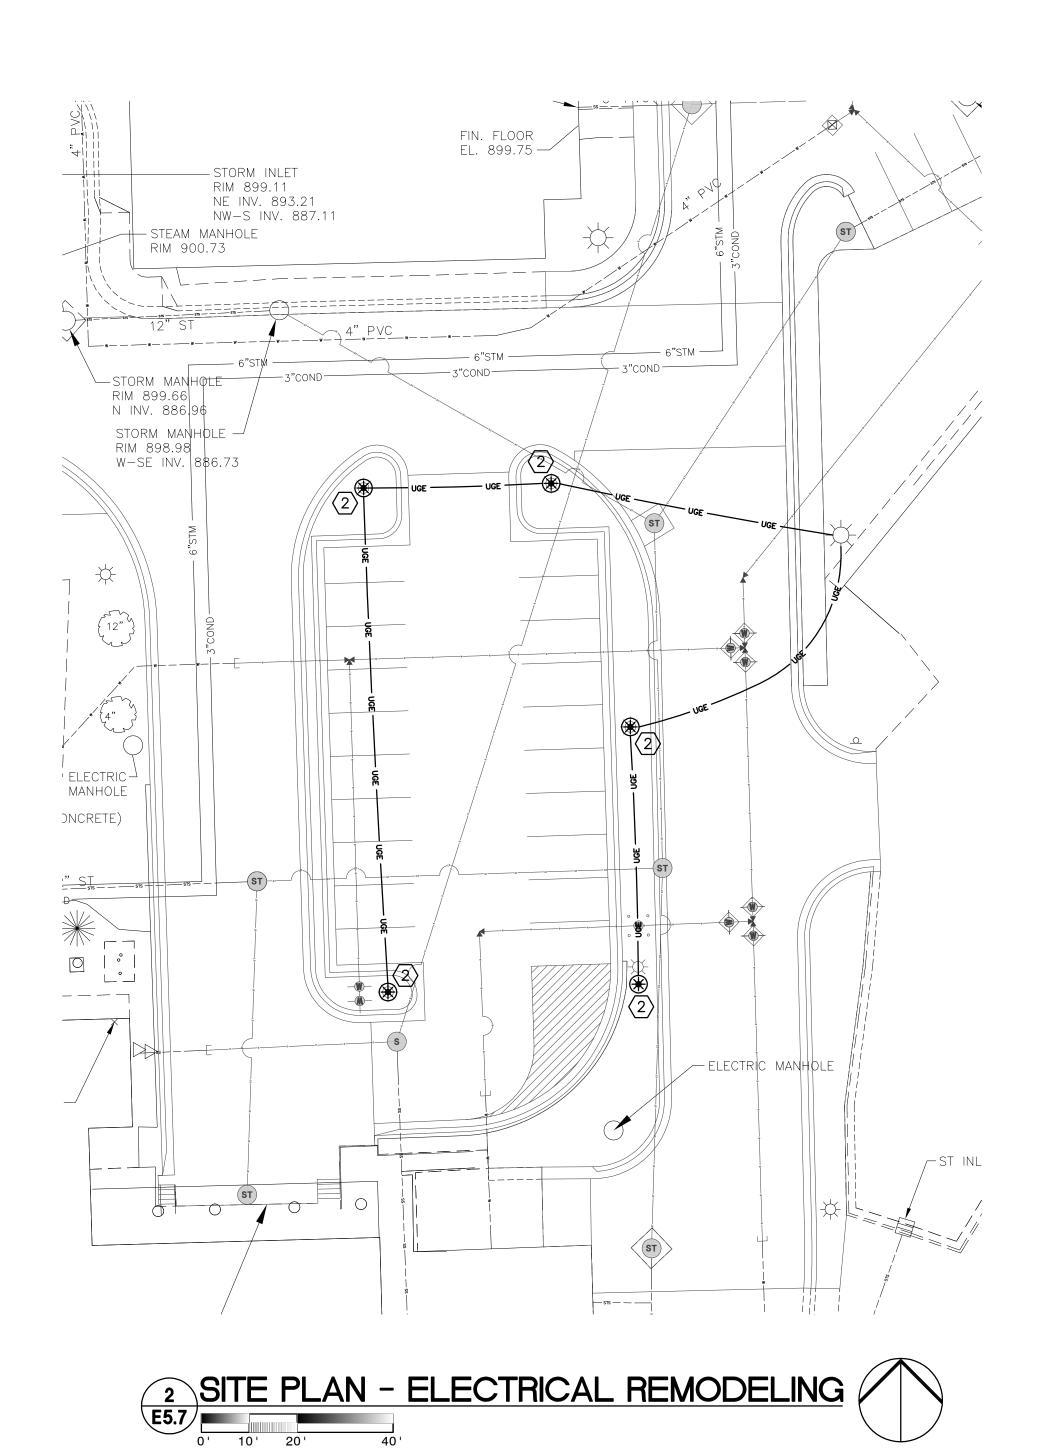
MAY 17, 2012 NTER AND ASPHALT SCALE AS NOTED Drawn By
TE VA MEDICAL CENTER FARGO, ND

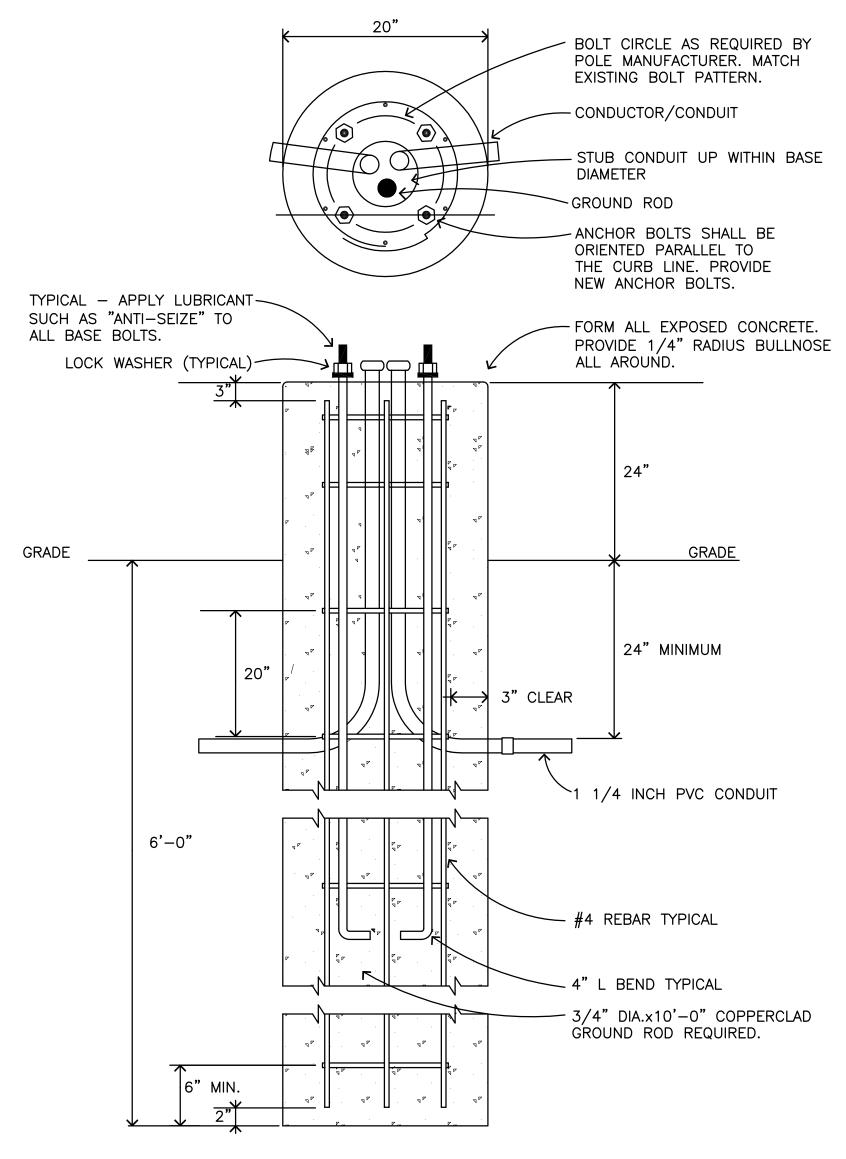
	ELECTRICAL SYMBOLS LEGEND	
SYMBOLS	DESCRIPTION	
	DASHED LINES INDICATE EXISTING FIXTURES, DEVICES, OR EQUIPMENT	
₩	POST TOP MOUNTED LIGHTING FIXTURE	
₽	ARM MOUNTED PARKING LOT LIGHTING FIXTURE	
∕ UGE ∖	UNDER GROUND ELECTRICAL	
(#)	NOTE IDENTIFICATION	

(1) LIGHT FIXTURE TO BE REMOVED AND SALVAGED FOR REINSTALLATION WHERE SHOWN ON 2/E5.7. PROVIDE STORAGE OF LIGHT FIXTURE DURING CONSTRUCTION. REMOVE POLE BASE. REMOVE CONDUCTORS BETWEEN LIGHT FIXTURES AND WIRING BACK TO SOURCE SHOWN.

 $\langle 2 \rangle$ REINSTALL LIGHT FIXTURE AND POLE SALVAGED DURING DEMOLITION. SEE LIGHT POLE BASE DETAIL 3/E5.7. MATCH CONDUCTOR SIZE AND NUMBER OF CONDUCTORS WITH EXISTING CIRCUITING. CIRCUIT AS SHOWN. PROVIDE #8 CONDUCTORS AND 1 1/4 INCH CONDUIT MINIMUM.







PROVIDE A SPARE CONDUIT STUB AT EACH END-OF-LINE FIXTURE. SEE PLANS FOR ADDITIONAL SPARE STUBS.

3 LIGHT POLE BASE DETAIL E5.7 NOT TO SCALE

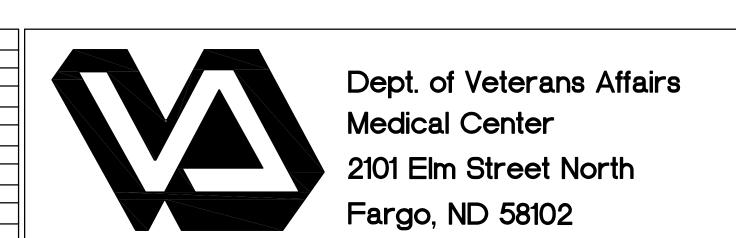




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Drawing Title	Project Title VA MEDICAL REPLACE UTILITY MA		
PHASE 5 - ELECTRICAL DEMOLITION AND ELECTRICAL REMODELING			
VA Project No. 437–11–156	Contract No. VA263-P-1217 VA263-C-	Designed By	Checked MB
Building No.	AutoCAD File Name	Location VA	MEDICAL

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Checked By MB Drawn By TP	Drawing No.	Depart Vetera
VA MEDICAL CENTER FARGO, ND	Dwg. 27 of 45	8

Date

Revisions

IMAGE GROUP INC. 403 CENTER AVENUE, SUITE 300 MOORHEAD, MN 56560